




- NOTES:
1. Culvert pipe must be either perforated corrugated metal pipe (16 gauge) or perforated polyethylene pipe. Pipe size to be 12".
  2. The existing drainage ditch must be cleaned and graded to drain across the entire highway frontage.
  3. The placement of the culvert is determined by the line, grade, and offset of the existing ditch and adjacent driveway culverts.
  4. The highway must be kept clean of mud, dirt and other debris at all times.
  5. All top soil and/or mud must be removed from the access prior to placement of the crushed stone for the access.

**TEMPORARY CONSTRUCTION ACCESS**  
N.T.S.

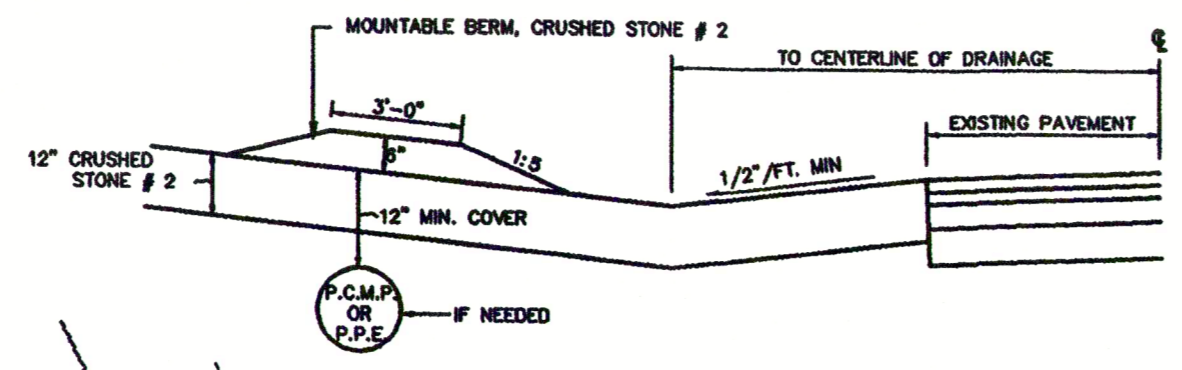

**LEGEND**


- Existing Catch Basin
- Proposed Catch Basin
- ⊙ Existing Storm Sewer manhole
- Proposed Storm Sewer Manhole
- ⊙ Existing Catch Basin Manhole
- ⊙ Existing Sanitary Manhole
- ⊙ Proposed Handicap Parking
- ✱ Existing Hydrant
- Spot Elevations
- ✕ Trees to be Removed

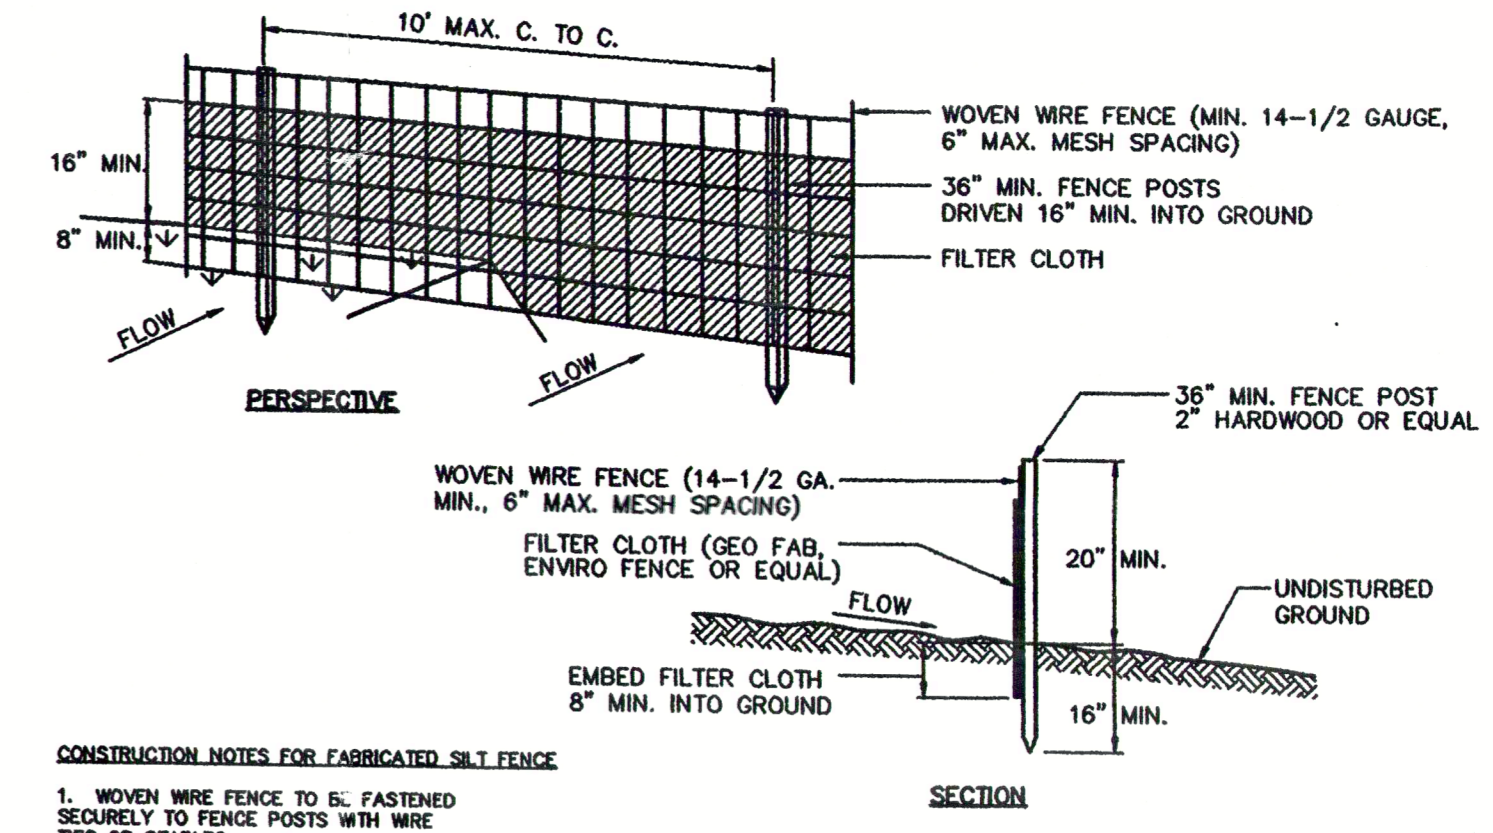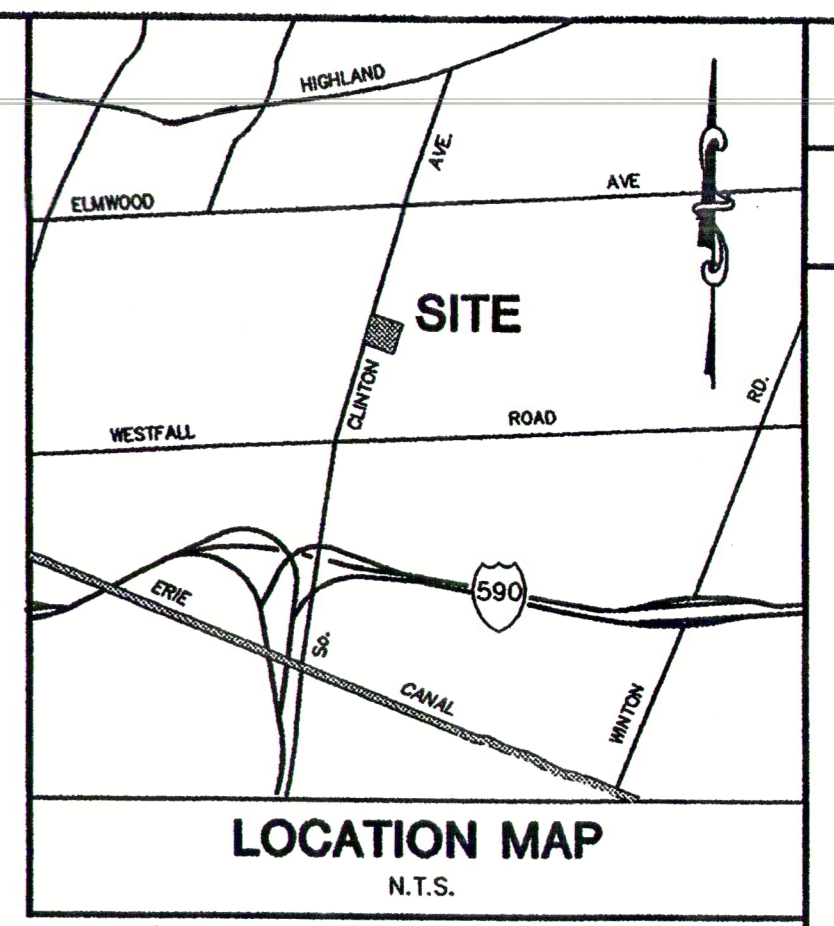

**CONSTRUCTION NOTES FOR FABRICATED SILT FENCE**

1. WOVEN WIRE FENCE TO BE FASTENED SECURELY TO FENCE POSTS WITH WIRE TIES OR STAPLES.
2. FILTER CLOTH TO BE FASTENED SECURELY TO WOVEN WIRE FENCE WITH TIES SPACED EVERY 24" AT TOP AND MID SECTION.
3. WHEN TWO SECTIONS OF FILTER CLOTH ADJOIN EACH OTHER, THEY SHALL BE OVERLAPPED BY SIX INCHES AND FOLDED.
4. MAINTENANCE SHALL BE PERFORMED AS NEEDED AND MATERIAL REMOVED WHEN 'BULGES' DEVELOP IN THE SILT FENCE.

**SILT FENCE**  
N.T.S.

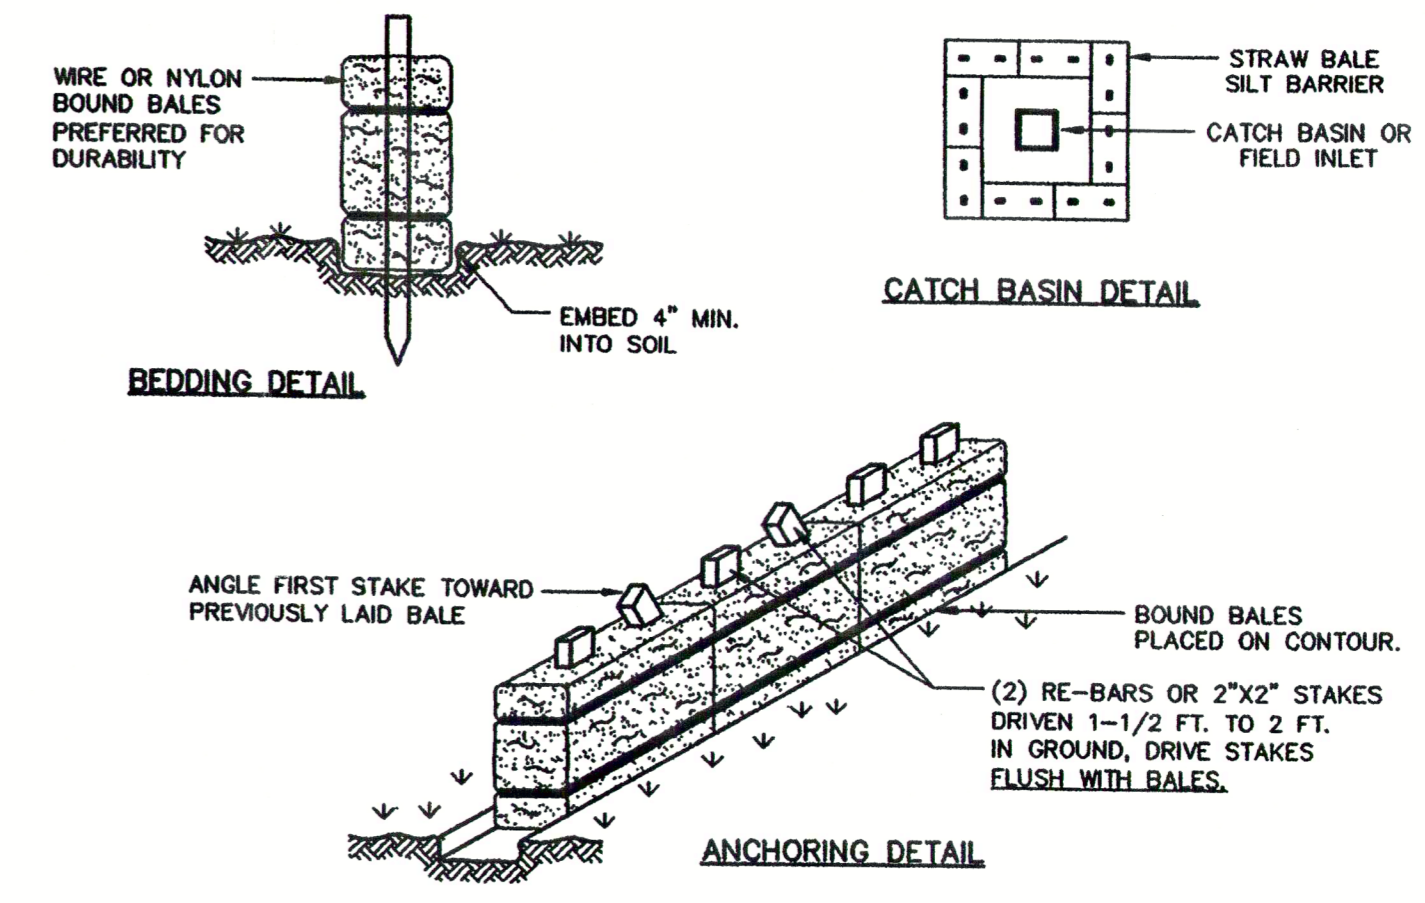


1. STRAW BALES SHALL BE PLACED AT THE TOE OF A SLOPE OR IN SWALE LINES AS SHOWN ON THE PLANS, WITH ENDS TIGHTLY ABUTTING THE ADJACENT BALES.
2. ALL CATCH BASIN INLETS SHALL BE SURROUNDED WITH STRAW BALES IMMEDIATELY FOLLOWING INSTALLATION.
3. EACH BALE SHALL BE EMBEDDED IN THE SOIL A MINIMUM OF (4) INCHES, AND PLACED SO THE BINDINGS ARE HORIZONTAL.
4. BALES SHALL BE SECURELY ANCHORED IN PLACE BY EITHER (2) STAKES OR RE-BARS DRIVEN THROUGH THE BALE. THE FIRST STAKE IN EACH BALE SHALL BE DRIVEN TOWARD THE PREVIOUSLY LAID BALE AT AN ANGLE TO FORCE THE BALES TOGETHER.
5. REPAIR AND OR REPLACEMENT OF BALES SHALL BE MADE PROMPTLY AS NEEDED TO CONTROL SITE RUNOFF.
6. STRAW BALES ARE FOR USE DURING CONSTRUCTION ONLY AND SHALL BE REMOVED WHEN THEY HAVE SERVED THEIR USEFULNESS SO AS NOT TO BLOCK OR IMPEDE STORM FLOW OR DRAINAGE.

**STRAW BALE DETAIL**  
N.T.S.

- NOTE:
1. THE PROJECT AND ITS CONSTRUCTION ENTRANCE SHALL MEET THE NEW YORK STATE GUIDELINES FOR URBAN EROSION AND SEDIMENT CONTROL.
  2. THE CONTRACTOR SHALL DESIGNATE A MEMBER OF HIS OR HER FIRM TO BE RESPONSIBLE TO MONITOR EROSION CONTROL, EROSION CONTROL STRUCTURES, TREE PROTECTION, AND PRESERVATION THROUGHOUT CONSTRUCTION.
  3. ALL TREES TO BE SAVED SHALL BE PROTECTED WITH ORANGE CONSTRUCTION FENCING PLACED AT THE DRIP LINE OR A DISTANCE GREATER THAN THE DRIP LINE. TREES SHALL BE PRUNED, WATERED, AND FERTILIZED PRIOR TO, DURING, AND AFTER CONSTRUCTION. MATERIALS AND EQUIPMENT STORAGE SHALL NOT BE ALLOWED IN FENCE AREAS.
  4. ALL DISTURBED AREAS SHALL BE PROTECTED FROM EROSION EITHER BY MULCH OR TEMPORARY SEEDING WITHIN TWO WEEKS OF DISTURBANCE.

MONROE COUNTY  
DEPT. OF TRANSPORTATION  
APPROVED: *[Signature]*  
DATE: 3 FEB 99  
APPLICATIONS FOR PERMITS  
WILL NOW BE ACCEPTED  
THIS PROJECT APPROVAL IS VALID  
FOR TWO (2) YEARS FROM ISSUANCE

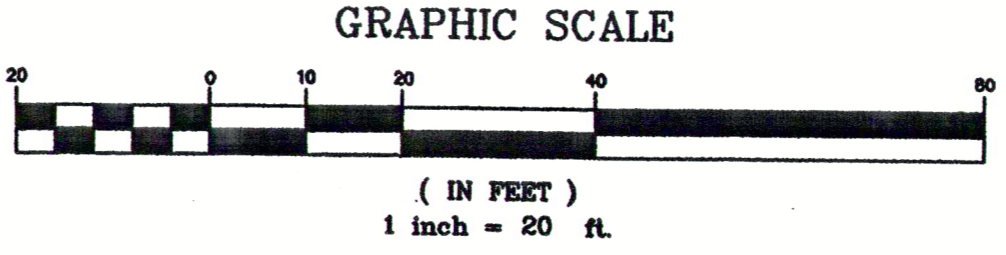

Project Title:	2020 S. CLINTON AVE TOWN OF BRIGHTON MONROE COUNTY, NEW YORK
Drawing Title:	GRADING
Drawn By:	SEW
Checked By:	MSG
Scale:	1" = 20'
Date:	9/22/98
No.:	1
REVISED PER TOWN COMMENTS	M.G.S. 11/12/98
Revisions and Descriptions	By Date
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110 WEST MILLER STREET, ROCHESTER, NEW YORK 14603 315-351-2860

Sheet No. **2** of **6**  
Project No. **291548**

DRAWING ALTERATION  
THE FOLLOWING IS AN EXCERPT FROM THE NEW YORK EDUCATION LAW ARTICLE 148 SECTION 7200  
AND APPLIES TO THIS DRAWING:  
"IT IS A VIOLATION OF THIS LAW FOR ANY PERSON UNLESS HE IS ACTING UNDER THE DIRECTION OF  
A LICENSED PROFESSIONAL ENGINEER OR LAND SURVEYOR TO ALTER IN ANY WAY, IF AN ITEM  
BEHIND THE SEAL OF AN ENGINEER OR LAND SURVEYOR IS ALTERED, THE ALTERING ENGINEER OR LAND  
SURVEYOR SHALL APPLY TO THE ITEM HIS SEAL AND THE NOTATION "ALTERED" FOLLOWED BY THE  
SIGNATURE AND THE DATE OF SUCH ALTERATION AND A SPECIFIC DESCRIPTION OF THE ALTERATION."